


Avoca High Street Picnic Shelter, Avoca

Schematic Design - REV

AUGUST 2019

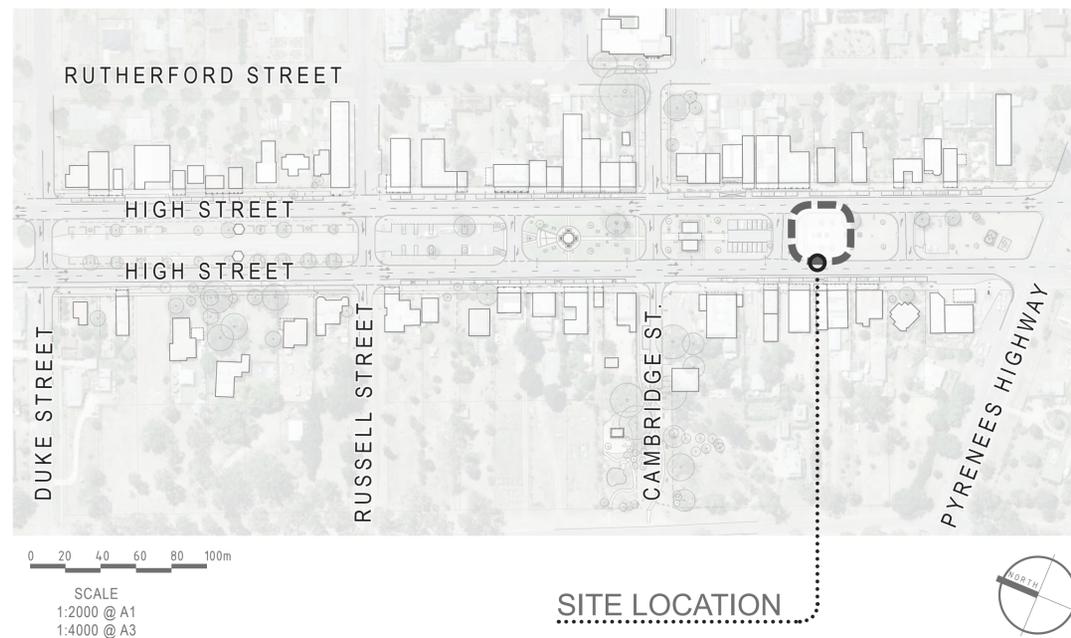


DESIGN INSPIRATION

The design of the picnic shelter proposed for the central median strip in High Street, draws inspiration from its rich historical surroundings.

The proposed shelter design consists of a lightweight contemporary structure which complements the streetscape and provides a shaded area for both locals and passers by to sit and enjoy.

The open form and high skillion roof allows unimpeded views along High Street towards the Avoca Soldiers' Memorial to the north.


The design also reflects the distinctly recognisable productive and rural aesthetic, characteristic of the Avoca township and greater landscape of the Pyrenees region.

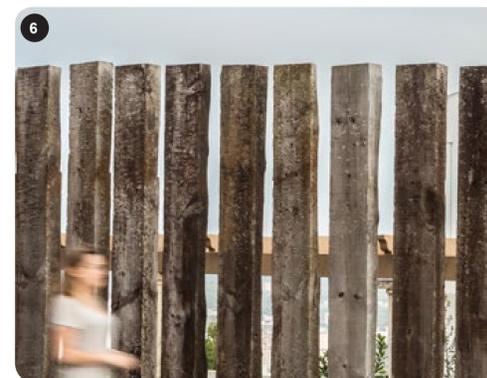

PROPOSED MATERIALS PALETTE

1. Steel mesh grape vine trellis.
2. Painted steel frame - Charcoal colour.
3. Weathered steel.
4. Corrugated roof sheeting. Zincalume Finish
5. Galvanised steel frame.
6. Recycled Red Gum Timber.

FOR: REVIEW		REV	AMENDMENTS	DATE	BY
DRAWN: ACL A	DATE: 26.07.19	A	COUNCIL FEEDBACK	19.08.19	MB
PROJECT N°: 1919	DWG N°: 1919-SD2				

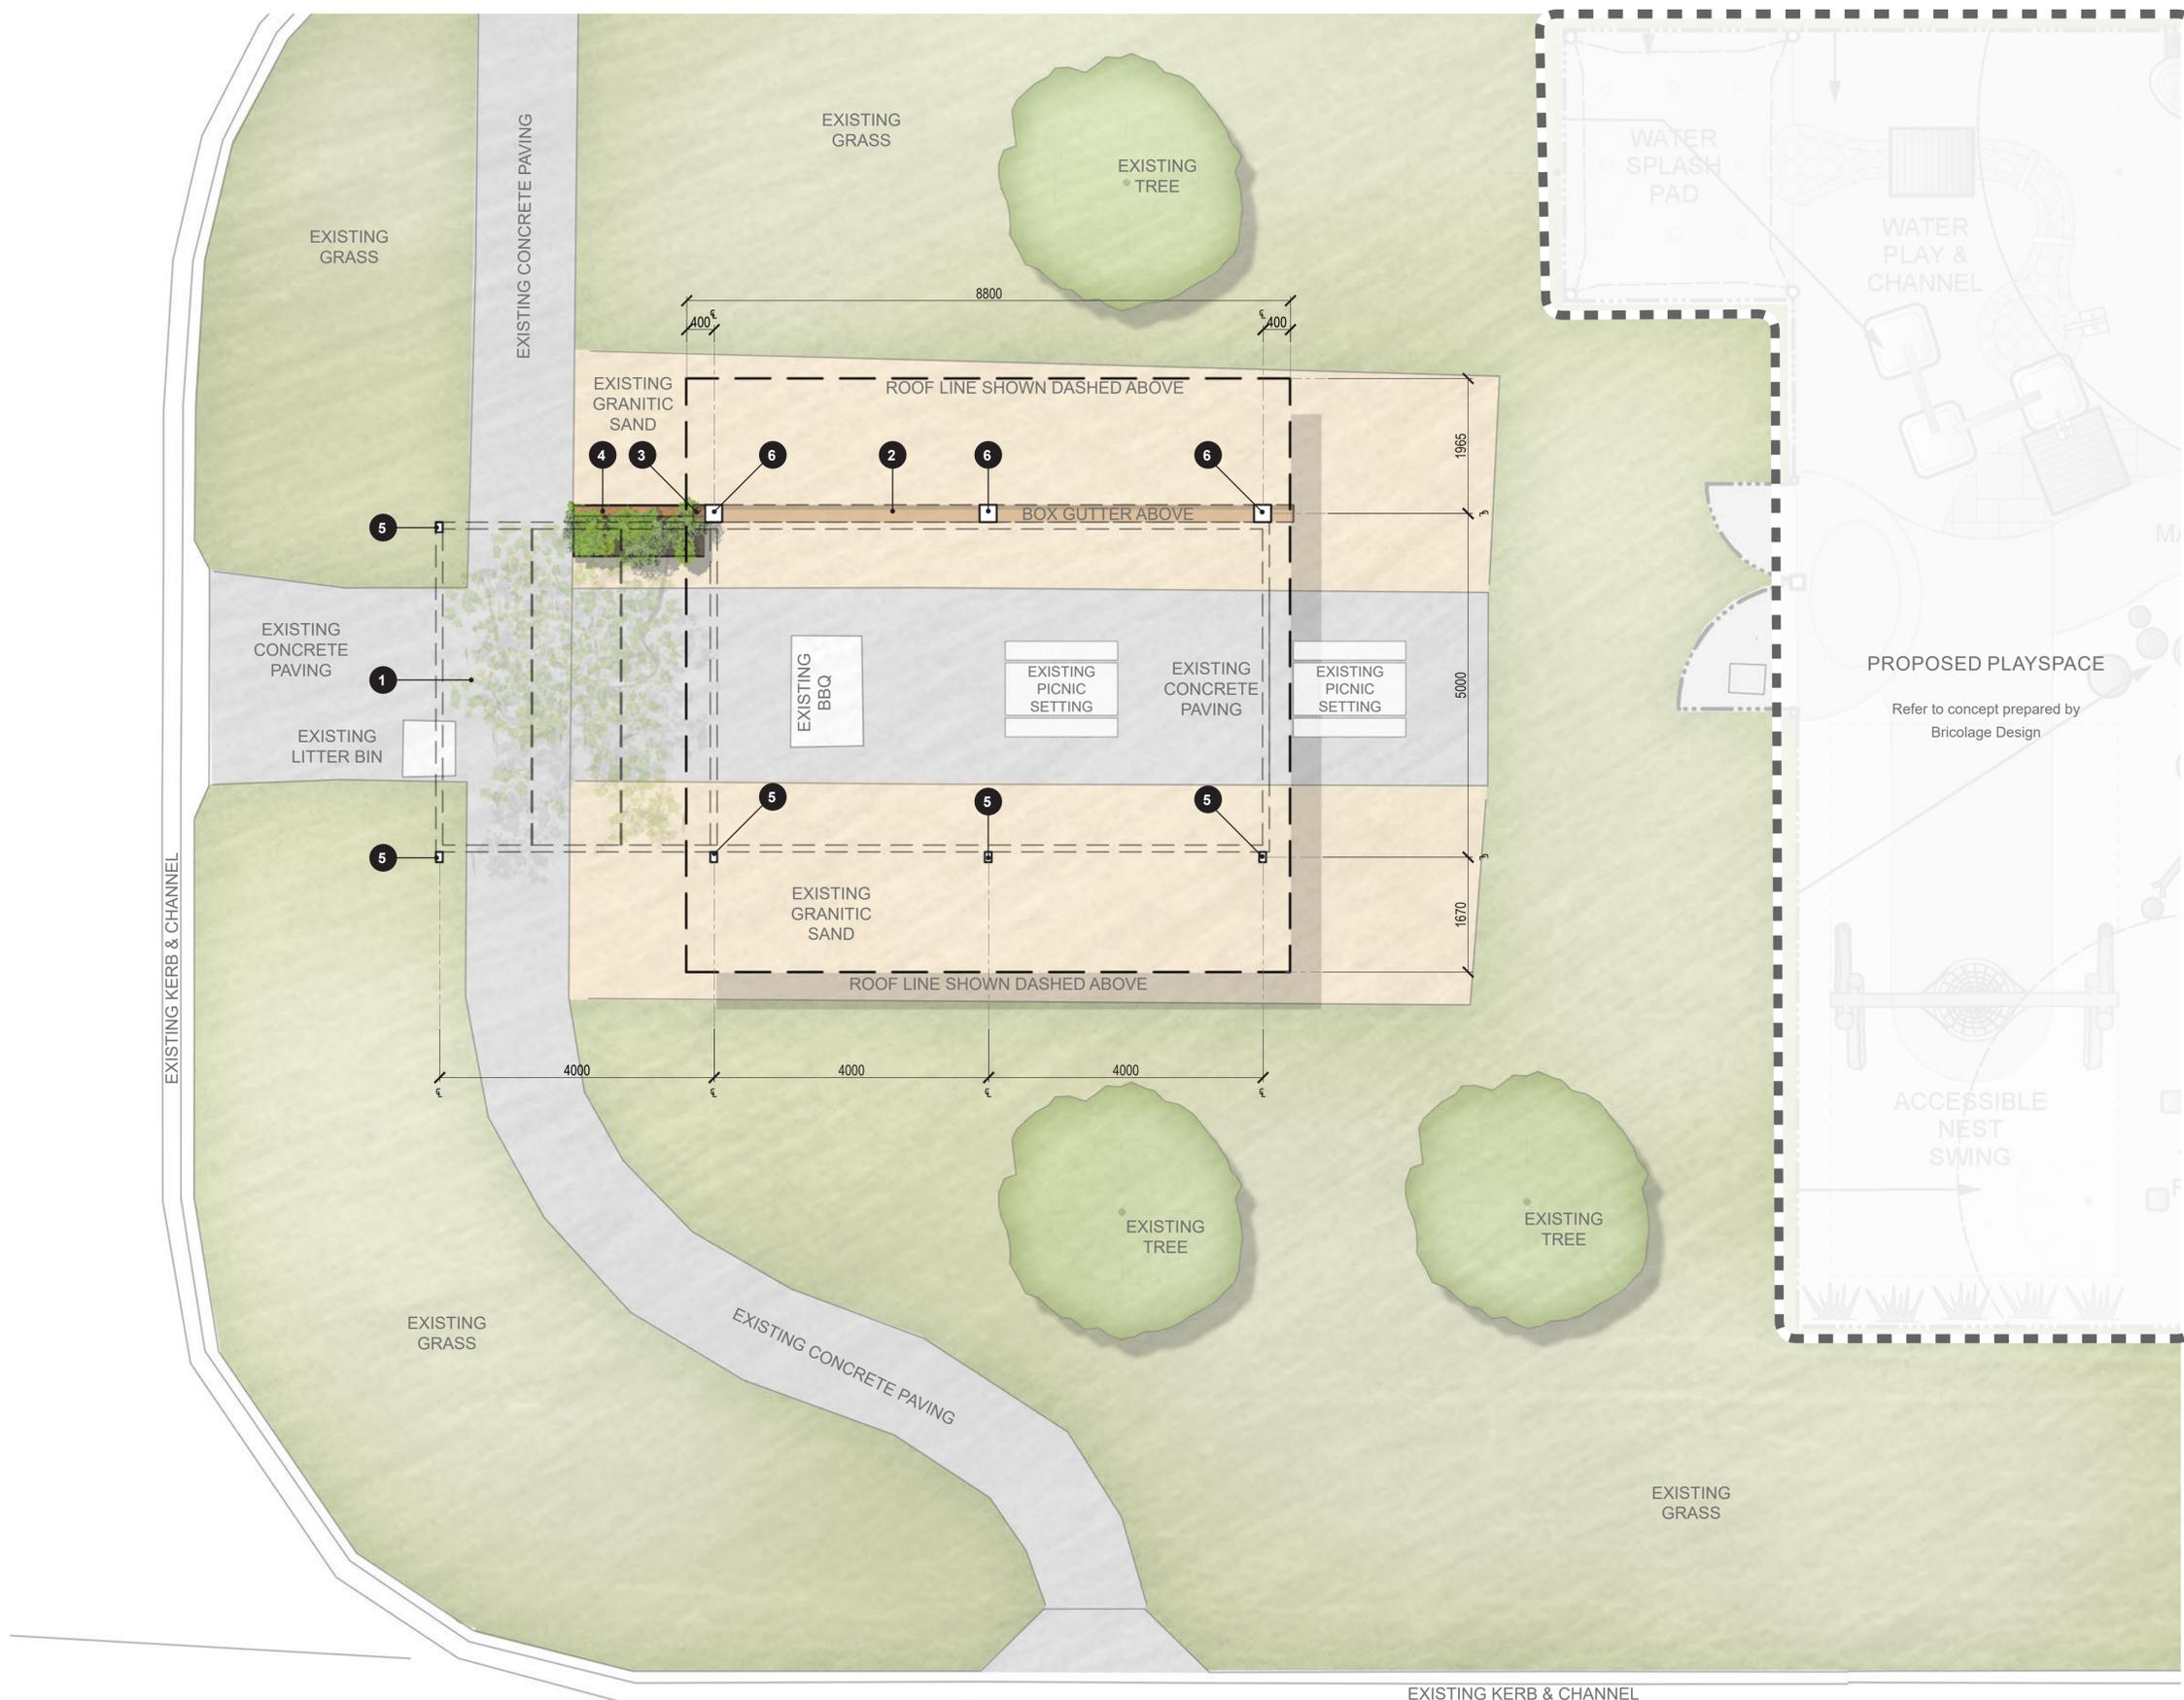


NOTES


1. Steel reinforcing mesh trellis for grape vine with steel angle support frame above existing BBQ.
2. Box gutter. Weathered Steel Finish.
3. Downpipe. Weathered Steel Finish.
4. Raised planter box for grape vine and BBQ herbs with inbuilt irrigation channel allowing passive irrigation from roof water runoff. Weathered steel finish.
5. Steel Post - Painted finish. Colour: Charcoal
6. Steel UC post with recycled Red Gum Timber inserts. Hot dipped galvanised finish.

HIGH STREET



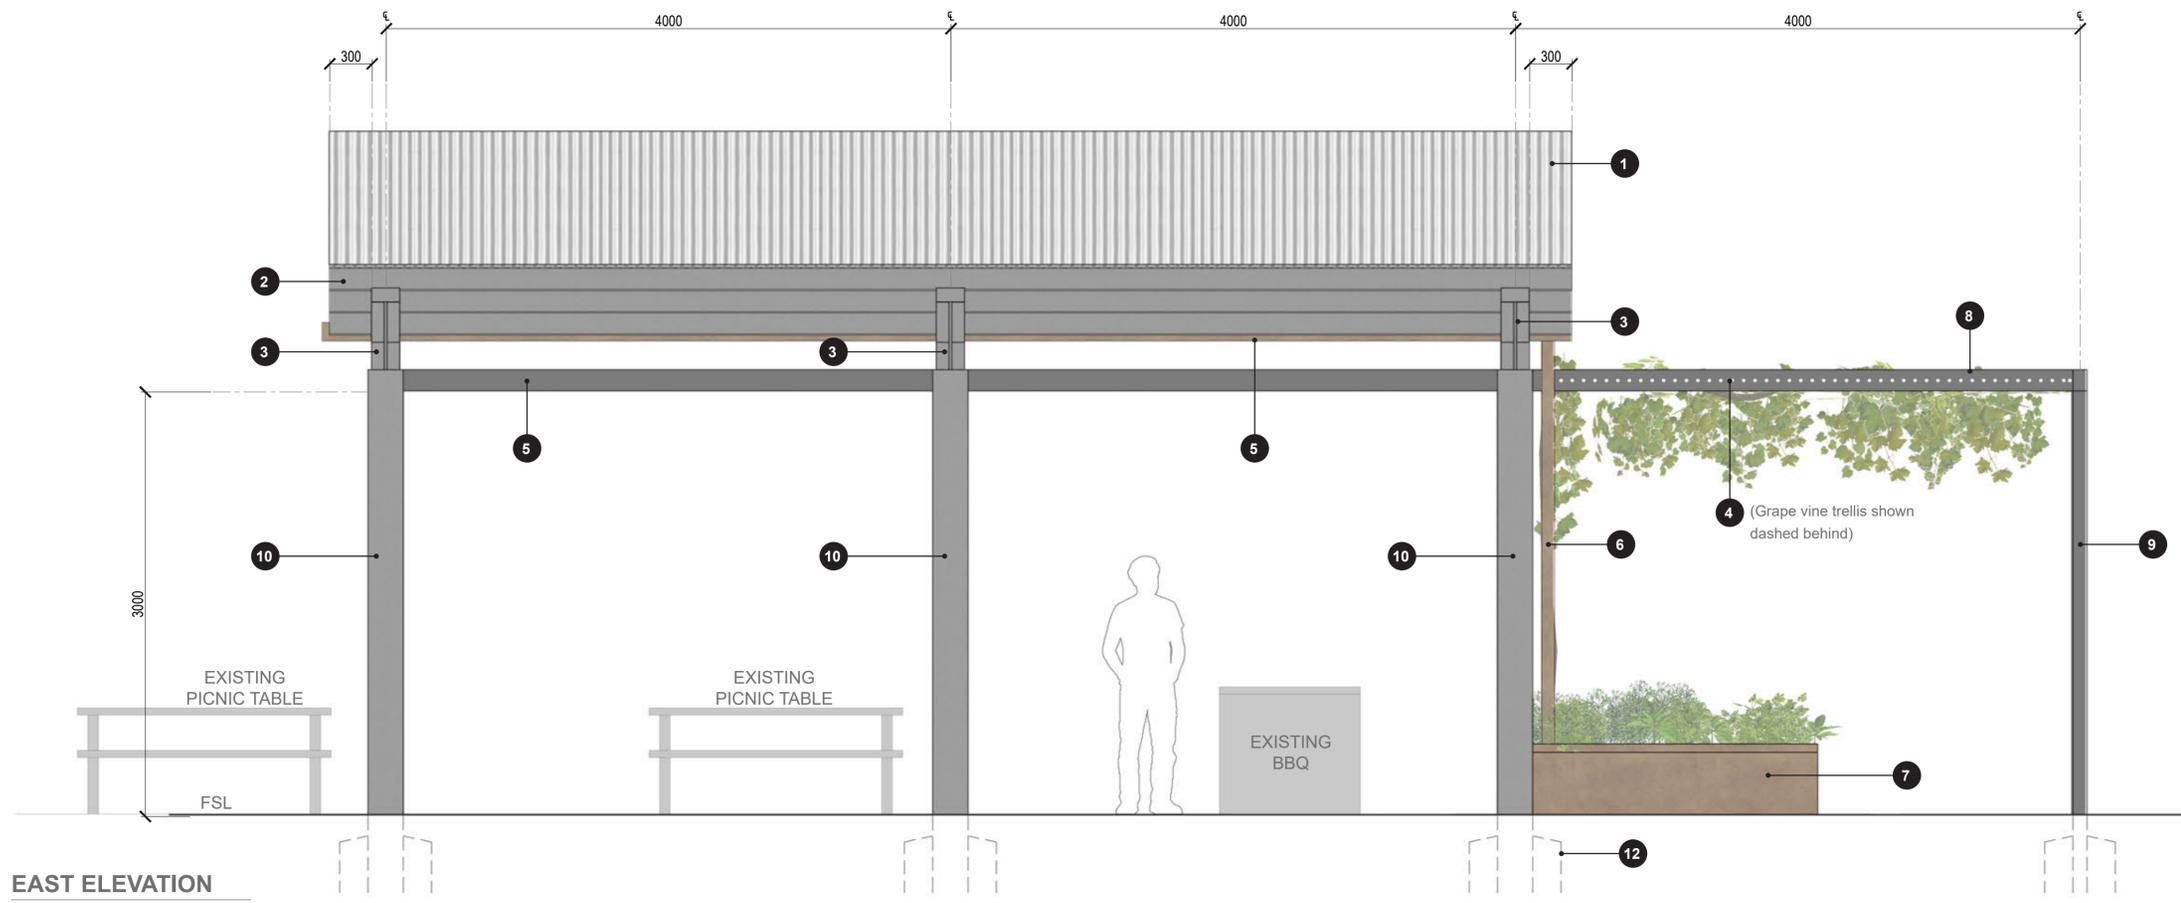

EAST ELEVATION
SCALE 1:25 @ A1 / 1:50 @ A3

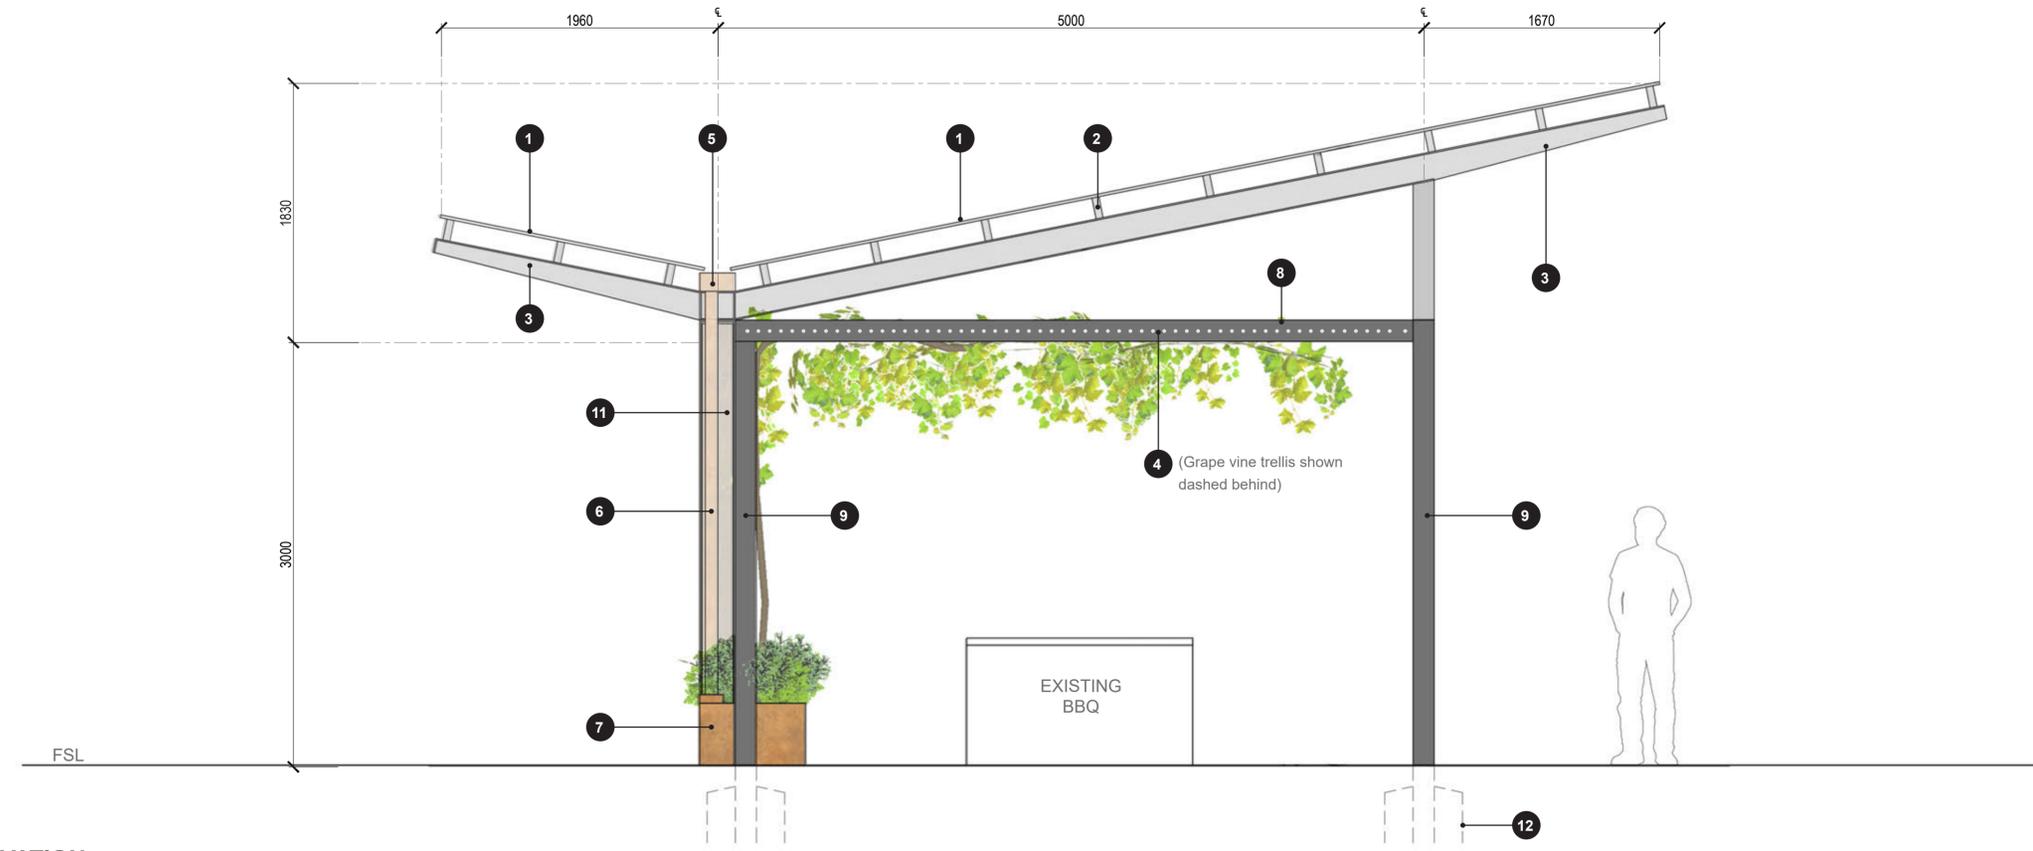


NORTH ELEVATION
SCALE 1:25 @ A1 / 1:50 @ A3


NOTES

1. Corrugated steel roof sheeting. Zinalume finish.
2. Steel purlins. Hot dipped galvanised finish.
3. Steel rafters with tapered ends. Hot dipped galvanised finish.
4. Steel reinforcing mesh grape vine trellis with steel angle support frame.
5. Box gutter. Weathered Steel Finish.
6. Downpipe. Weathered Steel Finish.
7. Raised planter box for grape vine and BBQ herbs with inbuilt irrigation channel allowing passive irrigation from roof water runoff. Weathered steel finish.
8. Steel Frame - Painted finish. Colour: Charcoal
9. Steel Post - Painted finish. Colour: Charcoal
10. Steel UC post. Hot dipped galvanised finish.
11. Recycled Red Gum Timber inserts to steel UC posts.
12. In-ground post and concrete footing.

FOR: REVIEW		REV	AMENDMENTS	DATE	BY
DRAWN: ACL A	DATE: 26.07.19	A	COUNCIL FEEDBACK	19.08.19	MB
PROJECT N°: 1919	DWG N°: 1919-SD4				

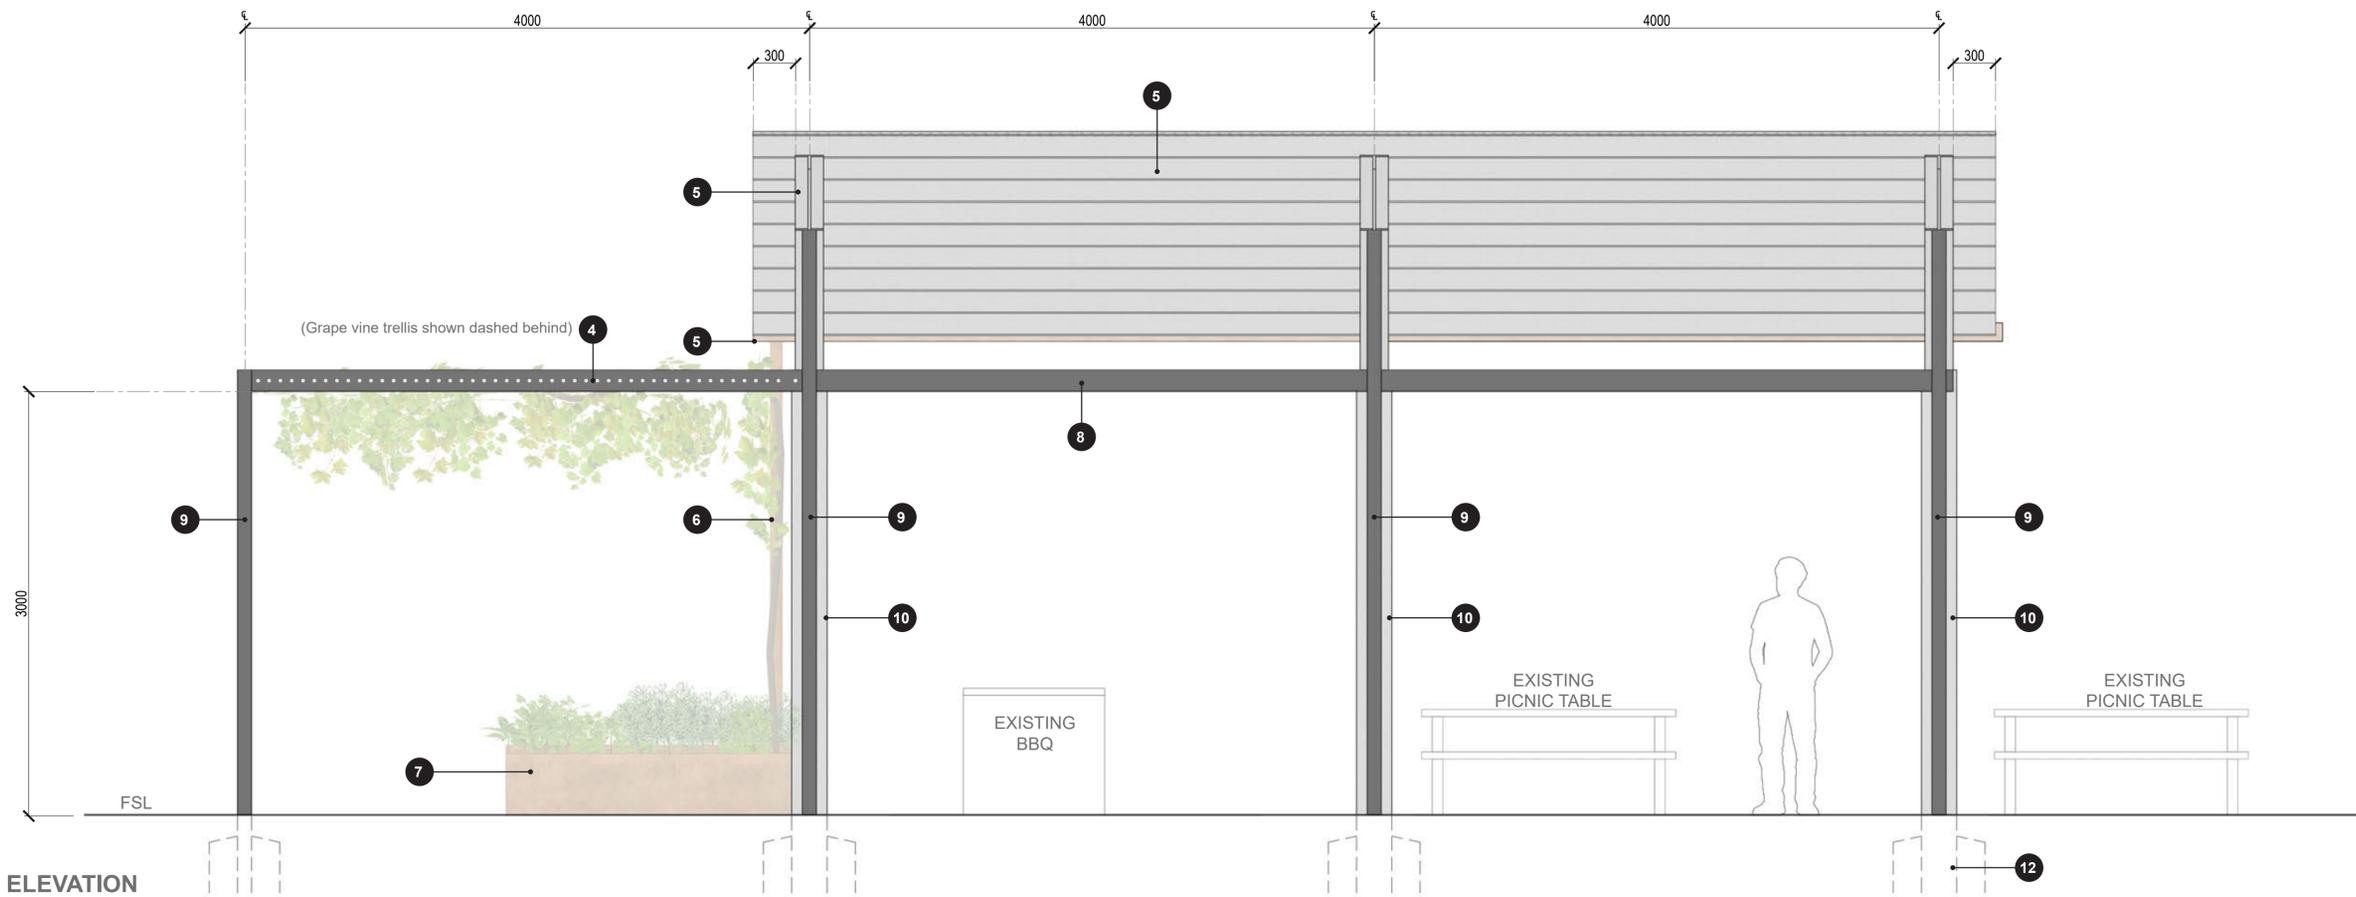

WEST ELEVATION
SCALE 1:25 @ A1 / 1:50 @ A3

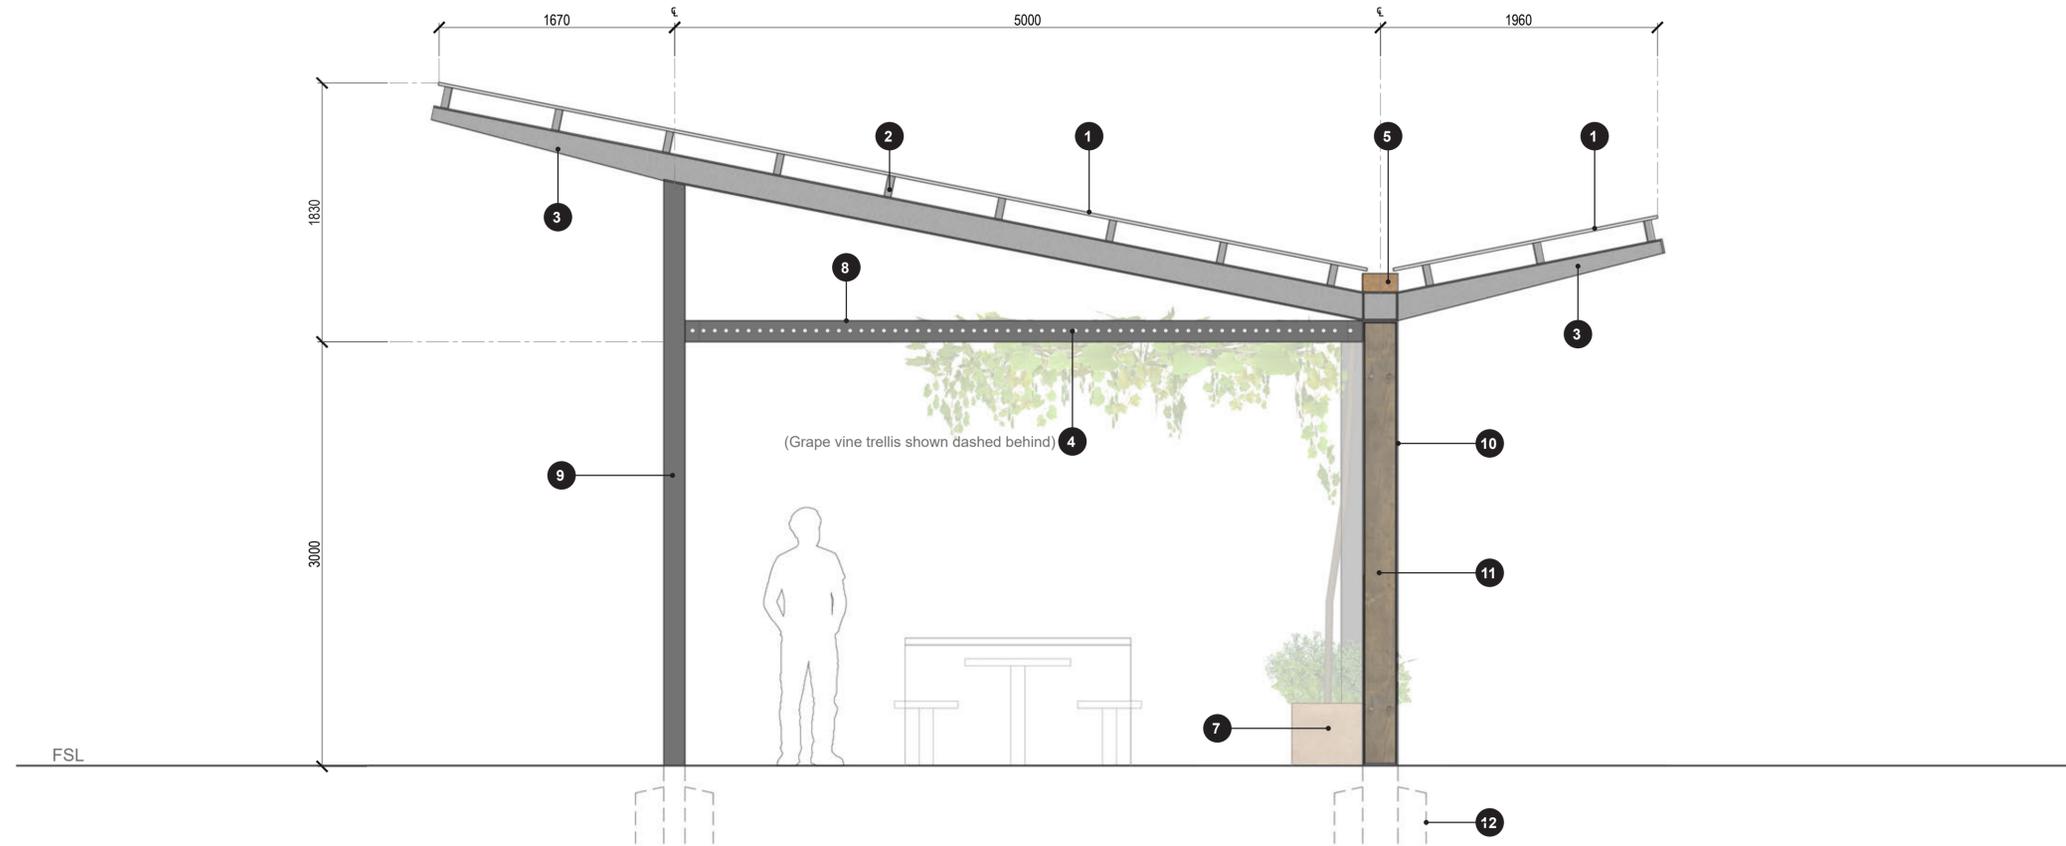

SOUTH ELEVATION
SCALE 1:25 @ A1 / 1:50 @ A3


NOTES

1. Corrugated steel roof sheeting. Zinalume finish.
2. Steel purlins. Hot dipped galvanised finish.
3. Steel rafters with tapered ends. Hot dipped galvanised finish.
4. Steel reinforcing mesh grape vine trellis with steel angle support frame.
5. Box gutter. Weathered Steel Finish.
6. Downpipe. Weathered Steel Finish.
7. Raised planter box for grape vine and BBQ herbs with inbuilt irrigation channel allowing passive irrigation from roof water runoff. Weathered steel finish.
8. Steel Frame - Painted finish. Colour: Charcoal
9. Steel Post - Painted finish. Colour: Charcoal
10. Steel UC post. Hot dipped galvanised finish.
11. Recycled Red Gum Timber inserts to steel UC posts.
12. In-ground post and concrete footing.

FOR: REVIEW		REV	AMENDMENTS	DATE	BY
DRAWN: ACL A	DATE: 26.07.19	A	COUNCIL FEEDBACK	19.08.19	MB
PROJECT N°: 1919	DWG N°: 1919-SD5				



ISOMETRIC VIEW
NOT TO SCALE

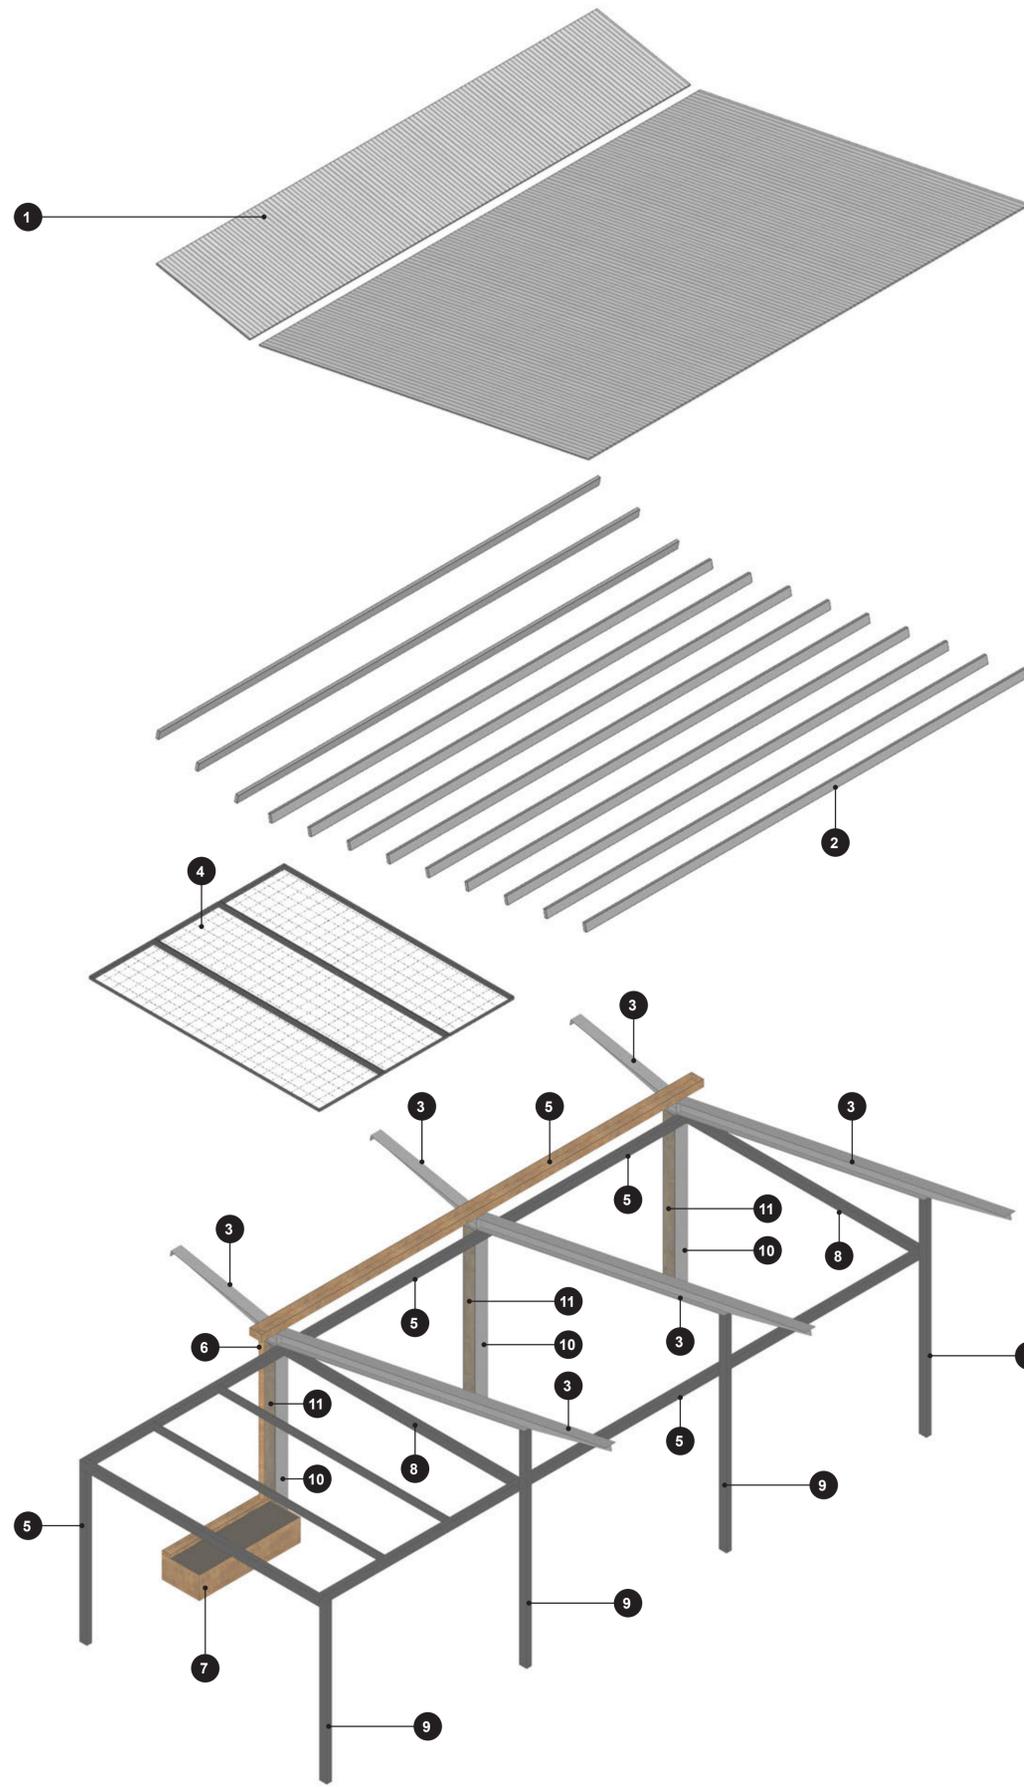

ISOMETRIC VIEW - EXPLODED
NOT TO SCALE

NOTES

1. Corrugated steel roof sheeting. Zinalume finish.
2. Steel purlins. Hot dipped galvanised finish.
3. Steel rafters with tapered ends. Hot dipped galvanised finish.
4. Steel reinforcing mesh grape vine trellis with steel angle support frame.
5. Box gutter. Weathered Steel Finish.
6. Downpipe. Weathered Steel Finish.
7. Raised planter box for grape vine and BBQ herbs with inbuilt irrigation channel allowing passive irrigation from roof water runoff. Weathered steel finish.
8. Steel Frame - Painted finish. Colour: Charcoal
9. Steel Post - Painted finish. Colour: Charcoal
10. Steel UC post. Hot dipped galvanised finish.
11. Recycled Red Gum Timber inserts to steel UC posts.

FOR: REVIEW		REV	AMENDMENTS	DATE	BY
DRAWN: ACLA	DATE: 26.07.19	A	COUNCIL FEEDBACK	19.08.19	MB
PROJECT N°: 1919	DWG N°: 1919-SD6				